

MetroWest*

Portishead Branch Line (MetroWest Phase 1)

TR040011

Applicant: North Somerset District Council

2.15 to 2.17 - Trinity Footbridge plans: Proposed General Arrangement Plan; Proposed Landscaping General Arrangement Plan; Electrical Layout General Arrangement

The Infrastructure Planning (Applications: Prescribed Forms and Procedure) Regulations 2009, regulation 5(2)(o) Planning Act 2008

Author: ARUP

Date: November 2019























Document Index

2.15	S051 Trinity Footbridge Proposed General Arrangement Plan	The Infrastructure Planning (Applications: Prescribed Forms and Procedure) Regulations 2009, regulation 5(2)(o)	W1097B-ARP-DRG-EST-300006 Rev A01	
2.16	S051 Trinity Footbridge Proposed Landscaping General Arrangement Sheets 1 and 2	The Infrastructure Planning (Applications: Prescribed Forms and Procedure) Regulations 2009, regulation 5(2)(o)	W1097B-ARP-DRG-ECV-300001-2 Rev A02	
2.17	S051 Trinity Footbridge Proposed Electrical Layout General Arrangement	The Infrastructure Planning (Applications: Prescribed Forms and Procedure) Regulations 2009, regulation 5(2)(o)	W1097B-ARP-DRG-EPT-300001 Rev A01	

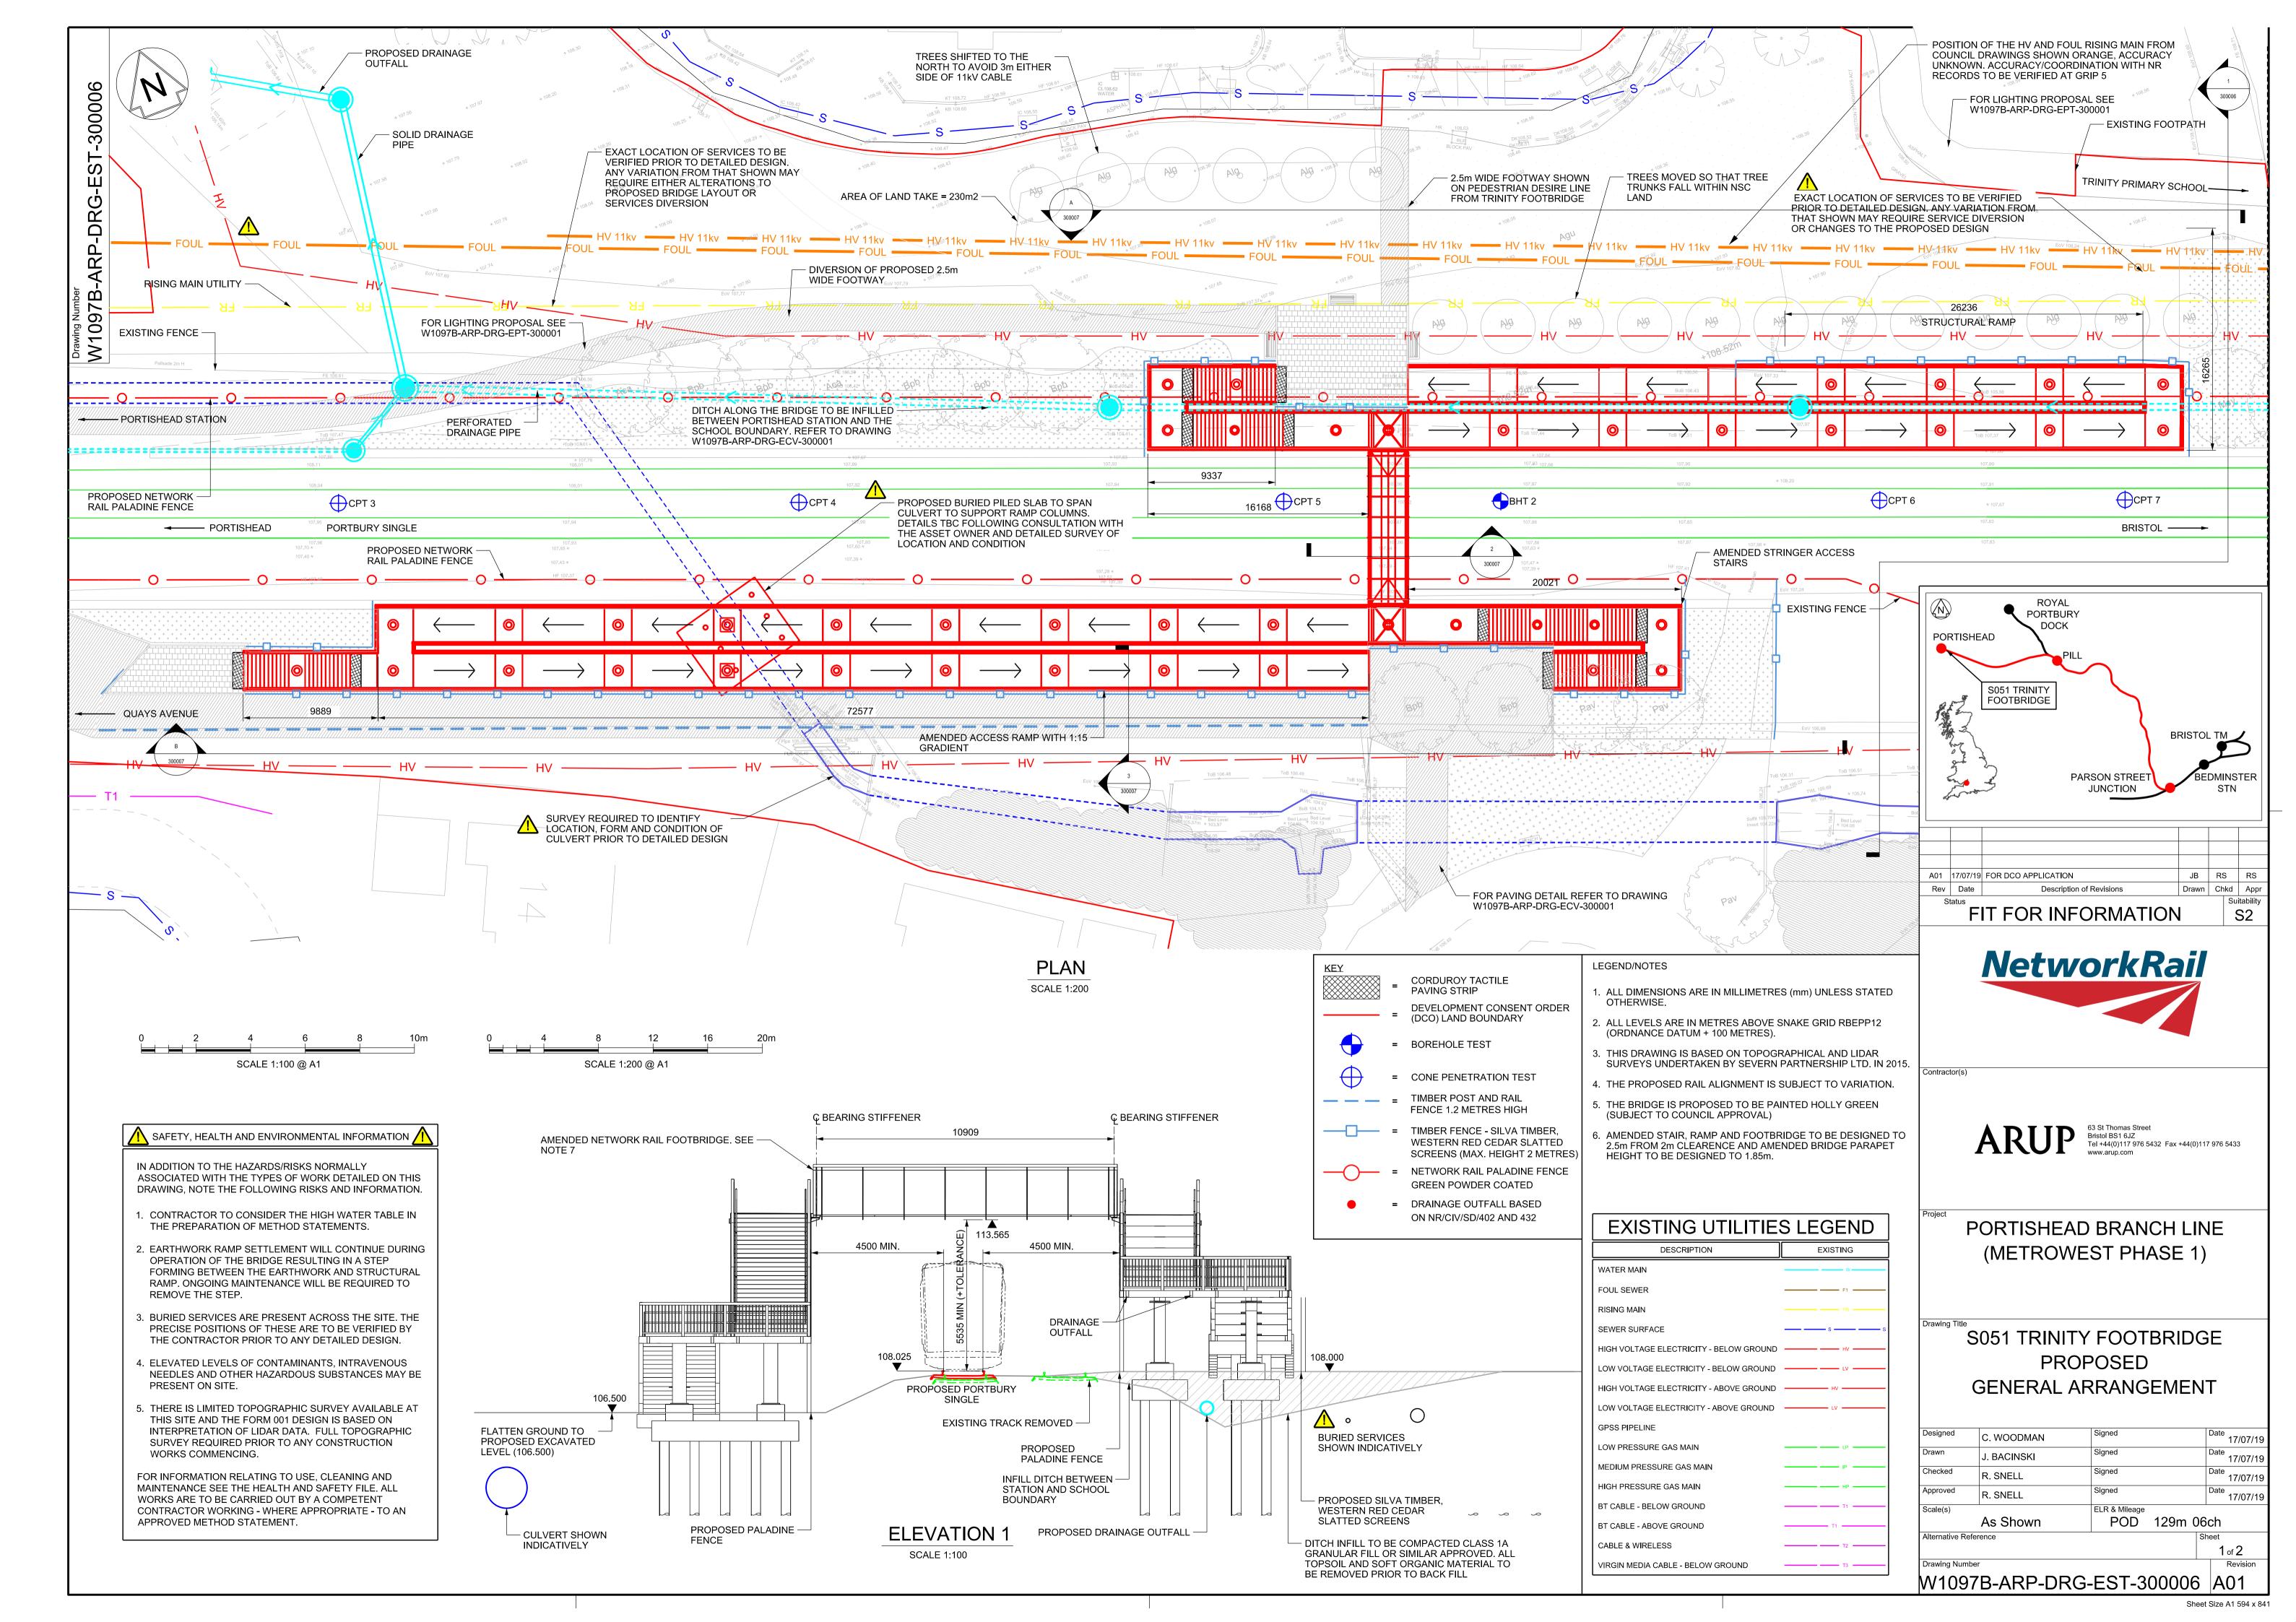

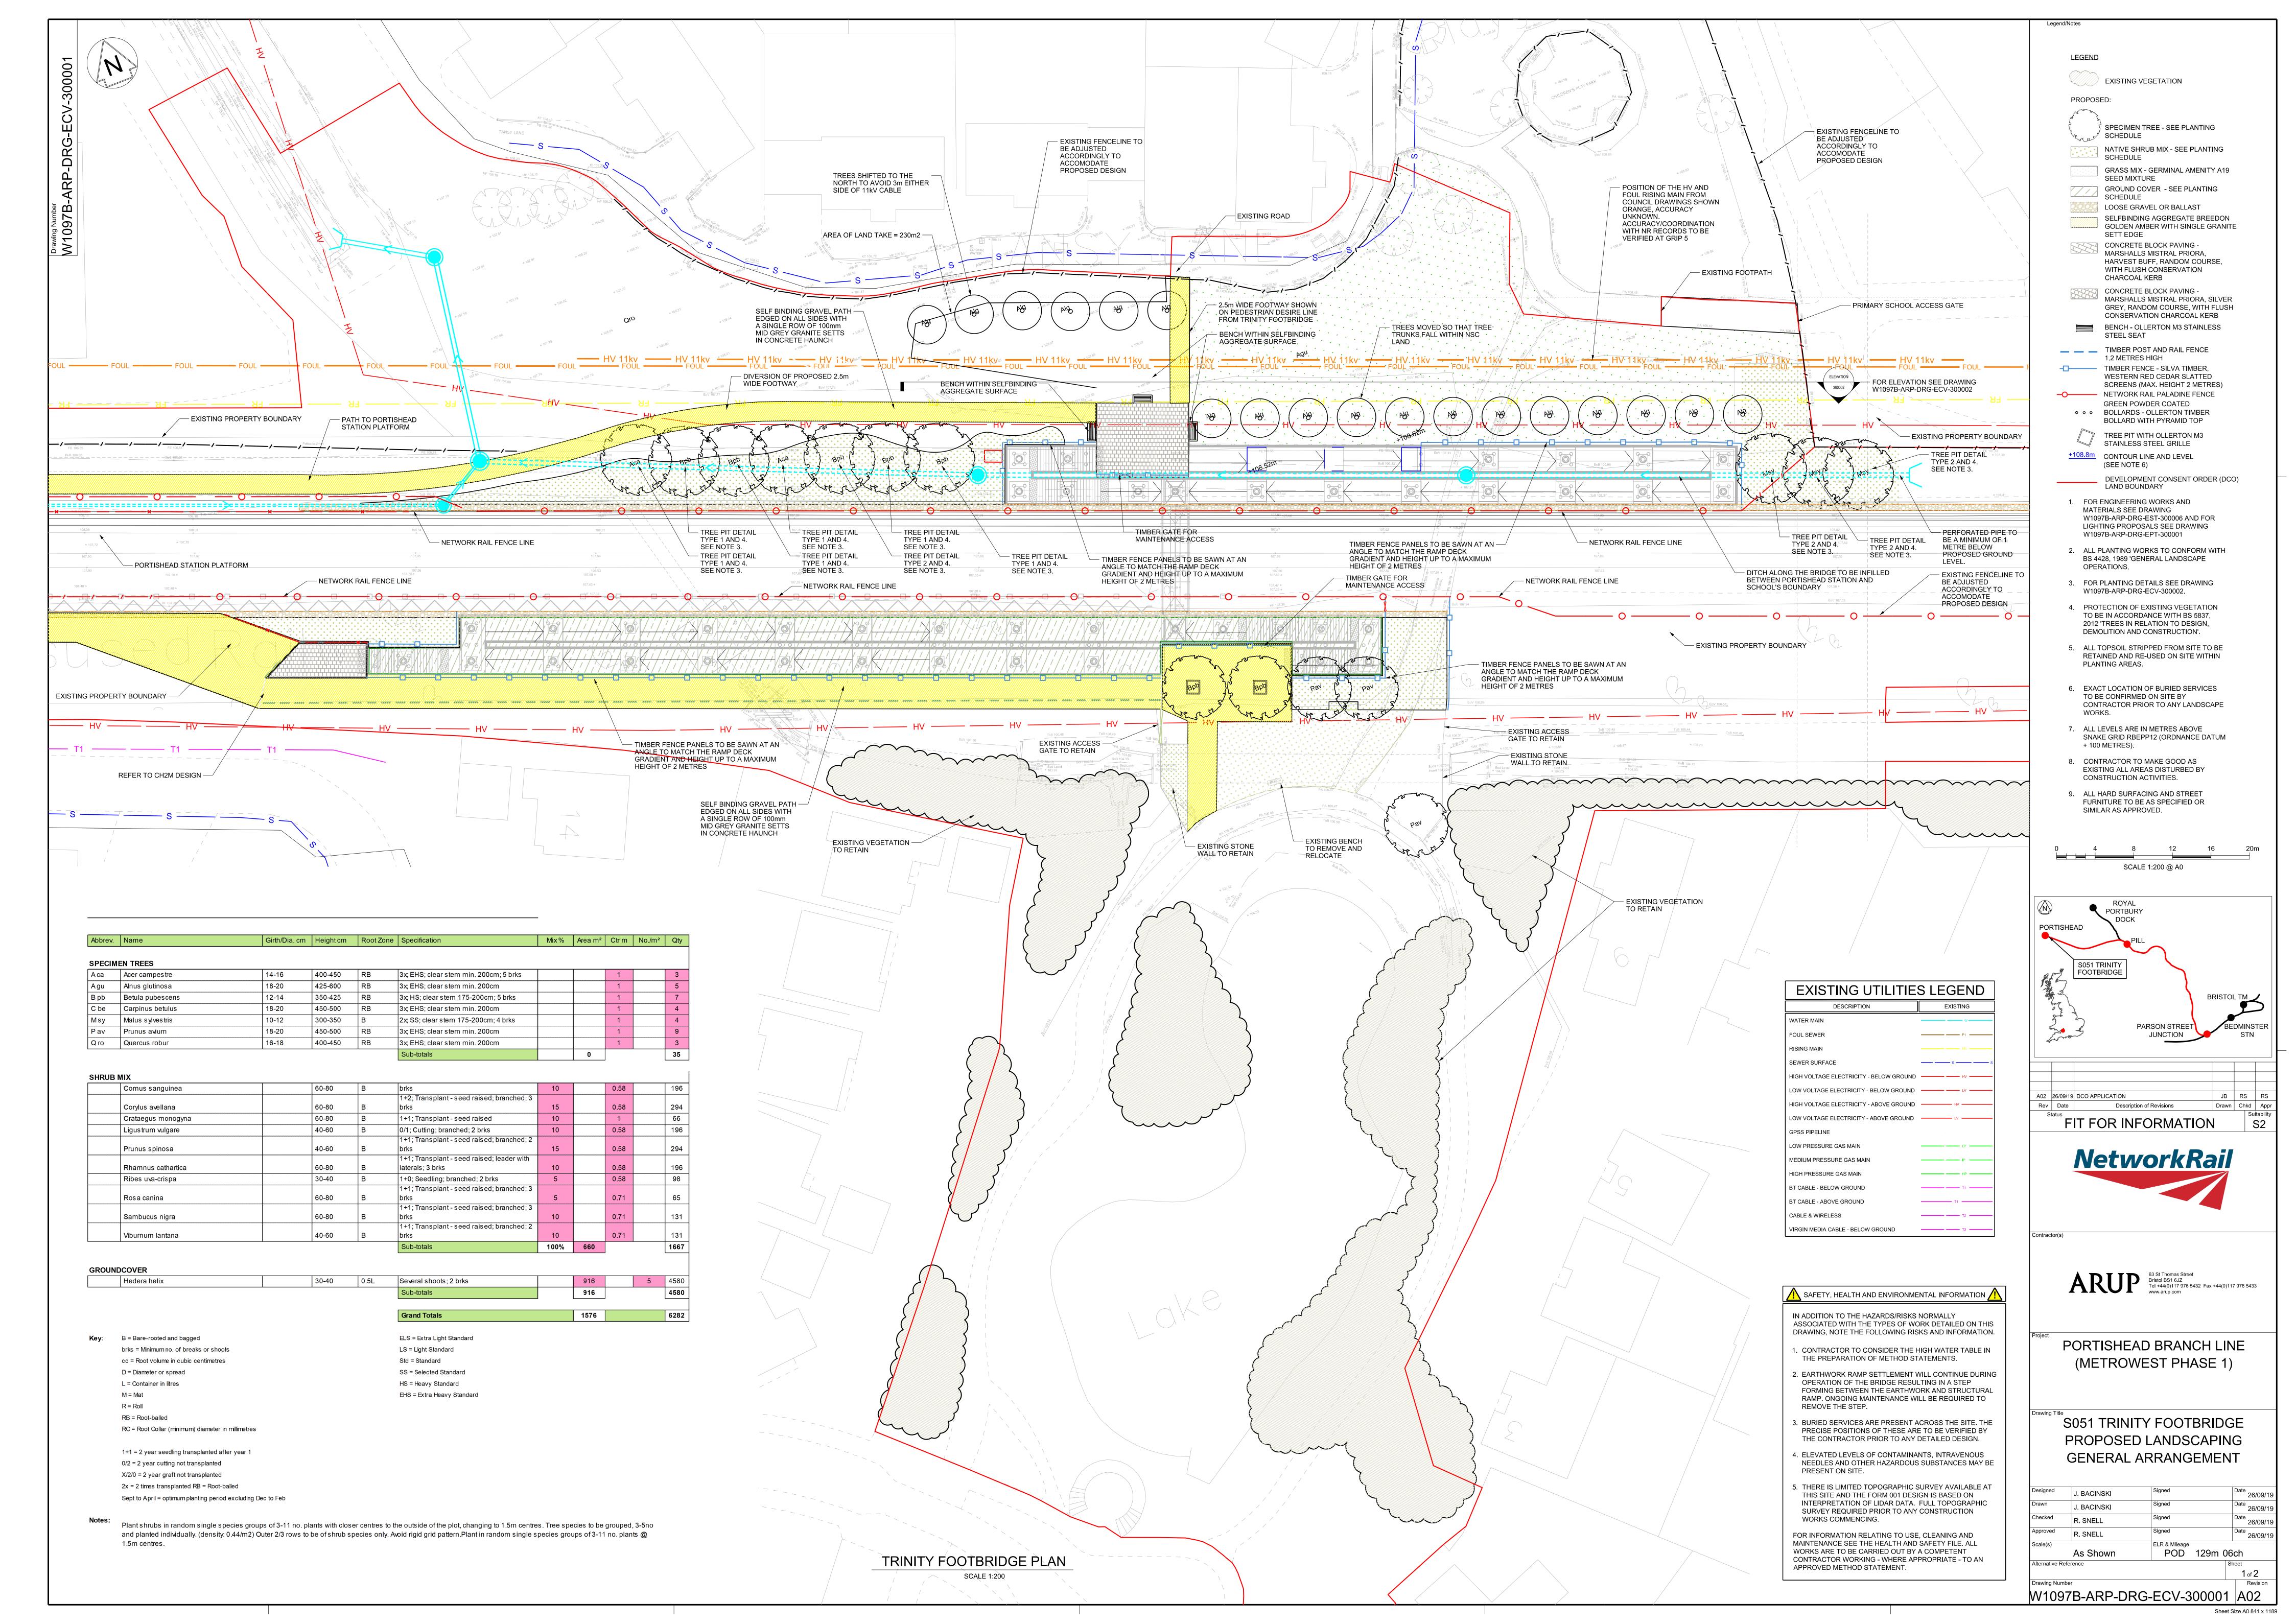


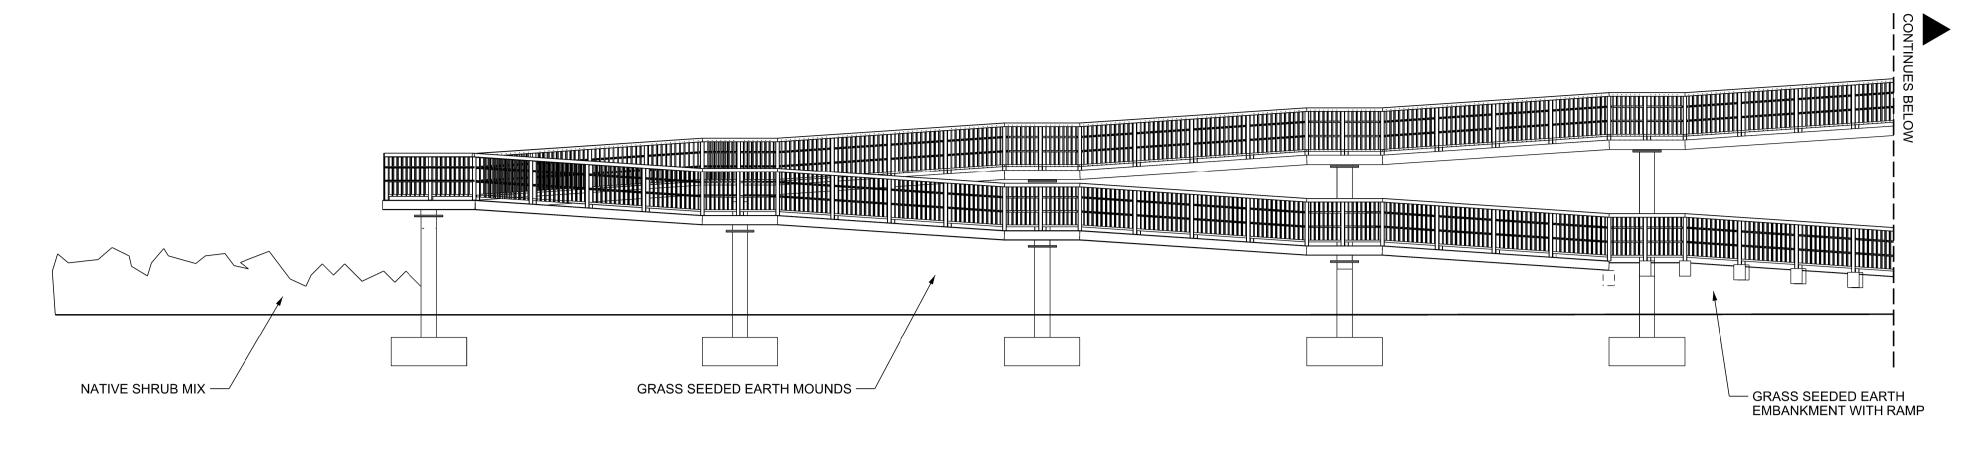

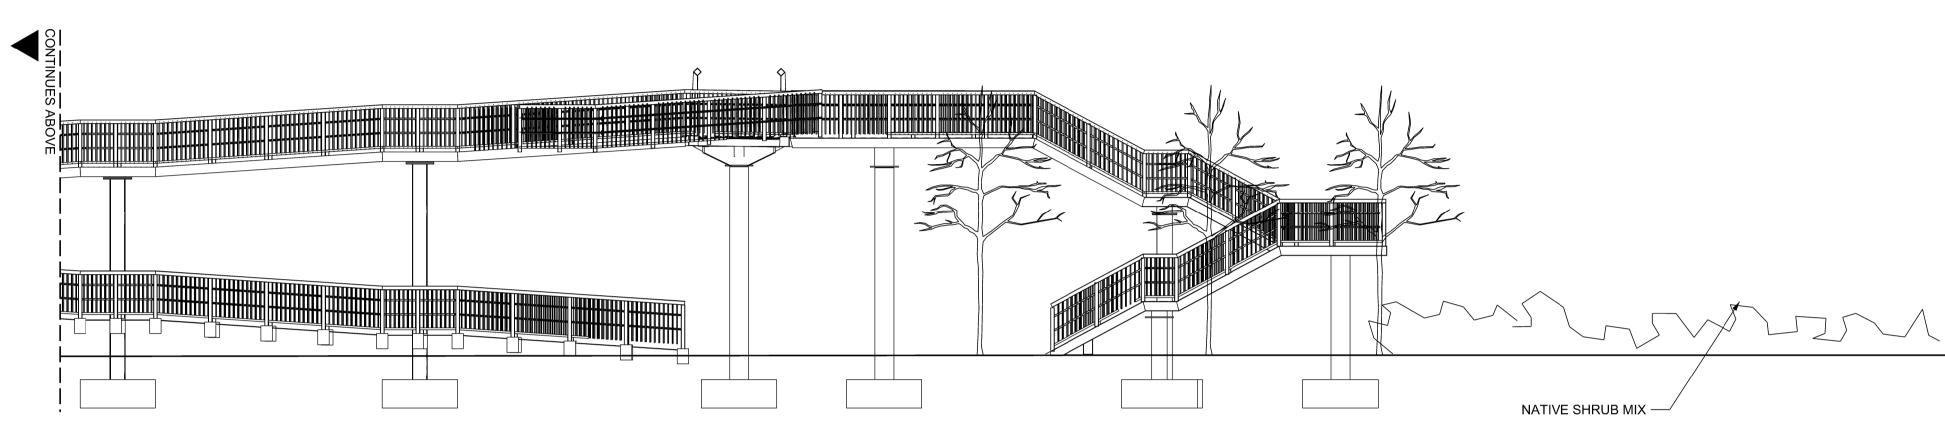

ELEVATION (FOR LOCATION SEE DRAWING W1097B-ARP-DRG-ECV-300001)

SCALE 1:100

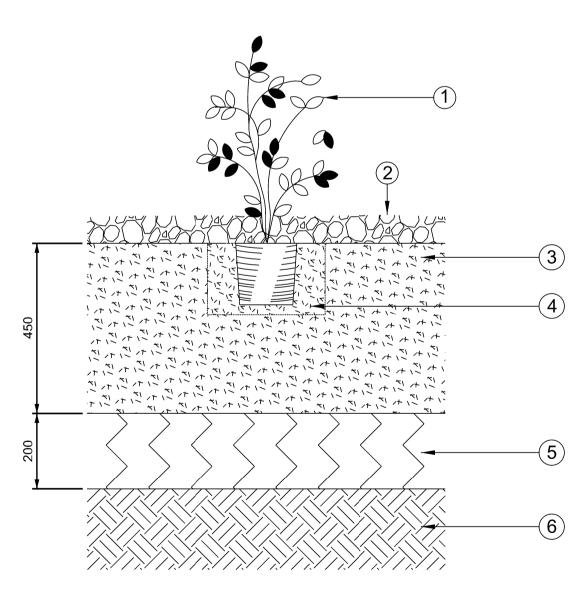


NOTES

- 1. ORNAMENTAL SHRUB OR GROUNDCOVER PLANT IN ACCORDANCE WITH THE PLANTING SCHEDULE. SEE NOTE D.
- 2. 75MM DEEP ORGANIC BARK MULCH IN SOFT LANDSCAPE AREAS. SAMPLE TO BE
- 3. 450MM TOPSOIL PLANTING BED.
- 4. PLANTING PITS TO BE 150 MM WIDER THAN THE ROOT SPREAD. THE SHRUBS SHALL BE SET IN THE HOLES SO THAT THE SOIL LEVEL, AFTER SETTLEMENT, WILL BE AT THE ORIGINAL ROOT COLLAR LEVEL ON THE STEM OF THE SHRUB. LOOSEN ROOTS AT BOTTOM OF COMPOST GENTLY WITH FINGERTIPS PRIOR TO PLANTING. THE HOLES SHALL BE BACKFILLED WITH 80% TOPSOIL TO 20% COMPOST, TO HALF THEIR DEPTH AND SHALL BE FIRMED BY TREADING. THE REMAINDER OF THE TOPSOIL SHALL THEN BE RETURNED AND AGAIN FIRMED BY TREADING.
- 5. EXISTING SUB GRADE TO BE RIPPED TO A DEPTH OF 200MM.
- 6. EXISTING SUB GRADE

DETAIL 1 - SHRUB PLANTING

SCALE 1:10

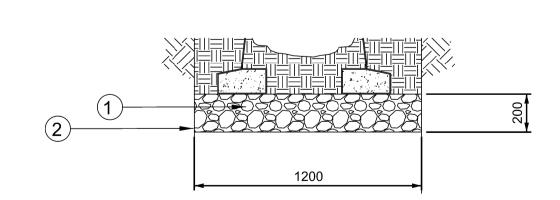


NOTES

- 1. 20-40MM GRAVEL CLEAN DRAINAGE LAYER.
- 2. GEOTEXTILE SEPERATION LAYER. GEOTEXTILE TO COMPLY WITH CLAUSE 609 AND SHALL SUSTAIN A TENSILE LOAD OF NOT LESS THAN 3.4KN/M AT 5% STRAIN, DETERMINED IN A "WIDE STRIP" TENSILE TEST CARRIED OUT ACCORDANCE WITH BS6909 PART 1

DETAIL 2 - TREE OVER PERFORATED DRAINAGE PIPE

SCALE 1:20

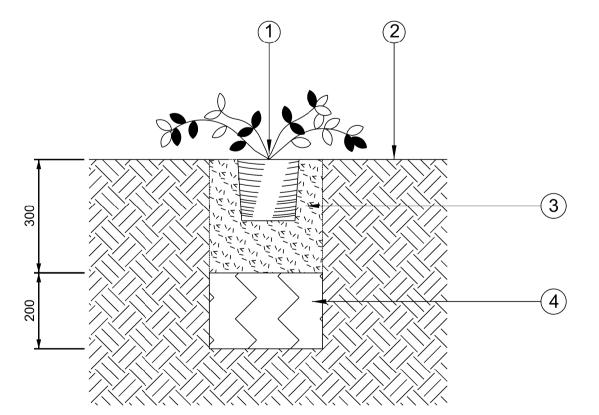


NOTES


- GROUNDCOVER OR HERBACEOUS PLANT IN ACCORDANCE WITH THE PLANTING SCHEDULE. SEE NOTE D.
- 2. EXISTING SOIL/VEGETATED AREAS.
- 3. PLANTING PITS TO BE DUG INTO EXISTING SOIL 150MM WIDER THAN THE ROOT SPREAD AND 300MM DEEP. THE PLANTS SHALL BE SET IN THE HOLES SO THAT THE SOIL LEVEL, AFTER SETTLEMENT, WILL BE AT THE ORIGINAL ROOT COLLAR LEVEL ON THE STEM OF THE SHRUB. LOOSEN ROOTS AT BOTTOM OF COMPOST GENTLY WITH FINGERTIPS PRIOR TO PLANTING. THE HOLES SHALL BE BACKFILLED WITH 80% TOPSOIL TO 20% COMPOST TO HALF THEIR DEPTH AND SHALL BE FIRMED BY TREADING. THE REMAINDER OF THE TOPSOIL SHALL THEN BE RETURNED AND AGAIN FIRMED BY TREADING.
- 4. EXISTING SUB GRADE TO BE RIPPED TO A DEPTH OF 200MM.


DETAIL 3 - GROUND COVER PLANTING

SCALE 1:10

- Legend/Notes
- A. ALL DIMENSIONS ARE IN MILLIMETRES (mm) UNLESS STATED OTHERWISE.
- B. ALL LEVELS ARE IN METRES ABOVE SNAKE GRID RBEPP12 (ORDNANCE DATUM + 100 METRES).
- C. THIS DRAWING SHOULD BE READ IN CONJUNCTION WITH THE CONTRACT DOCUMENTS.
- D. REFER TO DRAWING W1097B-ARP-DRG-ECV-300001 FOR PLANTING PLAN AND SCHEDULE.

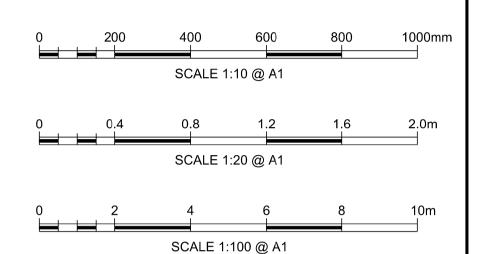

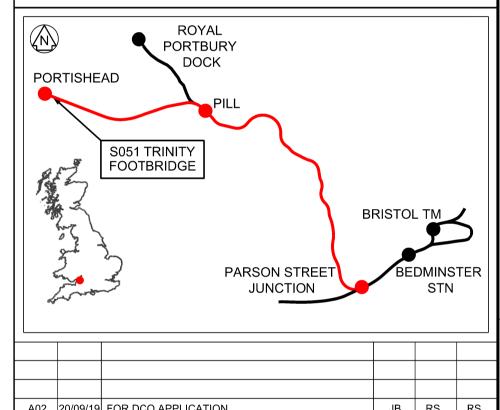

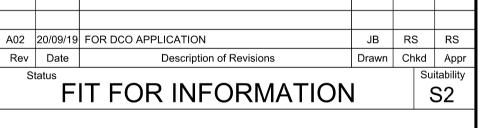



Contractor(s)



PORTISHEAD BRANCH LINE (METROWEST PHASE 1)

S051 TRINITY FOOTBRIDGE PROPOSED LANDSCAPING GENERAL ARRANGEMENT

Designed	J. BACINSKI	Signed Date 20/09/19
Drawn	J. BACINSKI	Signed Date 20/09/19
Checked	R. SNELL	Signed Date 20/09/19
Approved	R. SNELL	Signed Date 20/09/19
Scale(s)	•	ELR & Mileage
	As Shown	POD 129m 06ch

Alternative Reference

Drawing Number

W1097B-ARP-DRG-ECV-300002 A02

Sheet Size A1 594 x 841

2 of 2

